


LEGEND  
 HLS = HIGH LEVEL SWITCH  
 LLS = LOW LEVEL SWITCH  
 HHS = HIGH-HIGH LEVEL SWITCH  
 FM = FLOWMETER

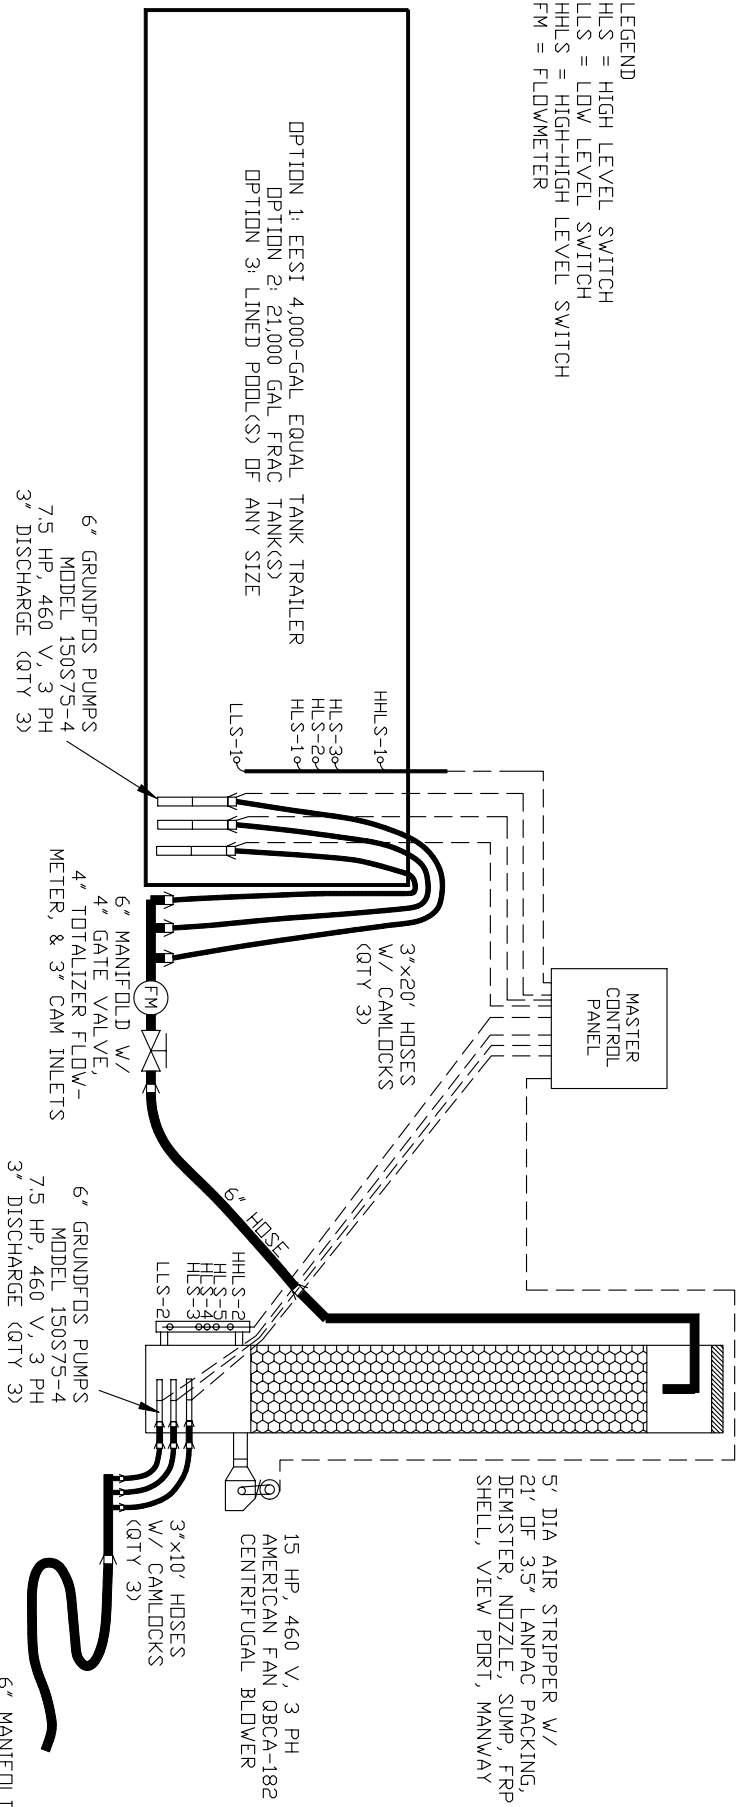

GENERAL NOTES:  
 1. SYSTEM INCLUDE INF & EFF SAMPLE PORTS.  
 2. AIR STRIPPER, CONTROL PANEL, BLOWER, & PUMP PUMPS ARE ALL INCLUDED ON TRAILER MOUNTED PACKAGED SYSTEM.

FIELD CONNECTIONS  
 1. INF PIPE OR HOSE TO EQUAL TANK BY OTHERS.  
 2. POWER CONNECTION-460V/3PH/100AMPS.  
 3. TREATED WATER DISCHARGE PIPING MAY OR MAY NOT BE INCLUDED DEPENDING ON DISTANCE TO DISCHARGE POINT.  
 4. SECONDARY TREATMENT EQUIPMENT, IF REQUIRED, CONNECTIONS BY OTHERS.

OPTIONS:  
 1. TRAILER MOUNTED GENERATOR POWER.  
 2. DISCHARGE BAG FILTERS.  
 3. DISCHARGE CARBON VESSELS.  
 4. MODIFICATIONS TO CONTROL PANEL TO INCORPORATE ADDITIONAL EQUIPMENT OR CONTROLS.

ELECTRICAL:  
 1. ALL EQUIPMENT PRE-WIRED TO MASTER CONTROL PANEL.  
 2. MOTORS ARE 3-PHASE 460 VAC; CONTROL POWER IS 120-VOLT.  
 3. CONTROL HAS MAIN DISCONNECT ON/DF.

LOAD CALCS:  
 INF PUMP 1 (7.5HP/460V/3PH) 11 AMPS  
 INF PUMP 2 (7.5HP/460V/3PH) 11 AMPS  
 INF PUMP 3 (7.5HP/460V/3PH) 11 AMPS  
 EFF PUMP 1 (7.5HP/460V/3PH) 11 AMPS  
 EFF PUMP 2 (7.5HP/460V/3PH) 11 AMPS  
 EFF PUMP 3 (7.5HP/460V/3PH) 11 AMPS  
 BLOWER (15HP/460V/3PH) 21 AMPS  
 FULL LOAD AMPS, ALL MOTORS 87 AMPS

MINIMUM REQD. GENERATOR SIZE IS 100kW, 3-PHASE W/ 460 VOLT OUTPUT. EESI CAN PROVIDE GENERATOR W/ POWER CABLE & MOBILE 250-GAL MOBILE TEMP. FUEL TANK AS OPTION.

CONTROL PANEL LDGIC  
 1. HAND-OFF-AUTO SWITCHES FOR ALL 7 MOTORS.  
 2. HLS-1, HLS-2, & HLS-3 ACTIVATE INF PUMPS 1,2,&3, RESPECTIVELY.  
 3. LLS-1 DEACTIVATES ALL 3 INFLUENT PUMPS.  
 4. HHS-1 ILLUMINATES RED FLASHING LIGHT ON TOP OF PANEL.  
 5. HLS-3, HLS-4, & HLS-5 ACTIVATE EFF PUMPS 4,5,&6, RESPECTIVELY.  
 6. LLS-2 DEACTIVATES ALL 3 INFLUENT PUMPS & ILLUMINATES FLASHING RED LIGHT ON TOP OF PANEL.  
 7. HHS-2 DEACTIVATES ALL 3 INFLUENT PUMPS & ILLUMINATES FLASHING RED LIGHT ON TOP OF PANEL.  
 8. MANUAL RESET REQUIRED FOR BOTH HIGH-HIGH CONDITIONS TO DE-ILLUMINATE RED FLASHING LIGHT ON TOP OF PANEL.  
 9. ALL MOTORS HAVE CIRCUIT BREAKER AND THERMAL OVERLOAD PROTECTION.  
 10. MAIN DISCONNECT DE-ENERGIZES ENTIRE SYSTEM.

5' DIA AIR STRIPPER W/ 21' OF 3.5" LANPAC PACKING, DEMISTER, NOZZLE, SUMP, FRP SHELL, VIEW PORT, MANWAY

15 HP, 460 V, 3 PH AMERICAN FAN QBCA-182 CENTRIFUGAL BLOWER

6" MANIFOLD W/ 3" CAM INLETS & 6" DISCHARGE

DRAWING

1

EESI 500 GPM MOBILE TREATMENT SYSTEM P&ID

ENGINEERED ENVIRONMENTAL SOLUTIONS INC.  
 601 N EAST COAST AVE, LANITANA, FL 33462  
 561-721-0062 PHONE / 561-721-0127 FAX

JOSEPH ZIEGLER, P.E.  
 PE NO. 49375  
 601 N EAST COAST AVE  
 LANITANA, FL 33462  
 561-721-0062  
 P.E. SEAL

SCALE: N.T.S.  
 DATE: 5-15-06  
 DRAWN BY: JNZ  
 CHECKED BY: JNZ  
 APPROVED BY: JNZ

No.	REVISIONS	BY	DATE





